




NOTE: CONSTRUCTION AND FINISH MATERIALS TO MATCH EXISTING INFORMATION DESK IN CITY HALL LOBBY.

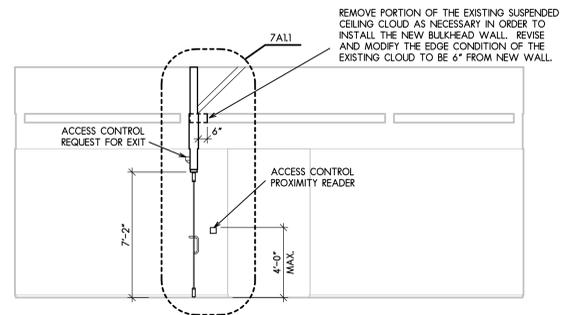


5 WEST ELEVATION
SCALE: 1/4" = 1'-0"

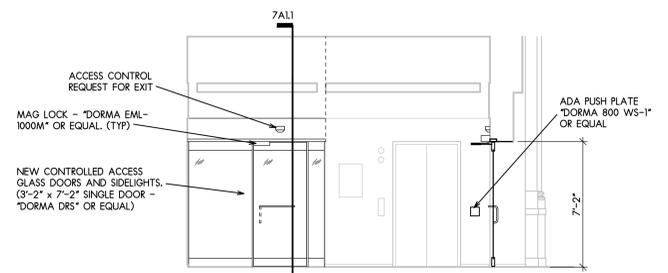


4 NORTH ELEVATION
SCALE: 1/4" = 1'-0"

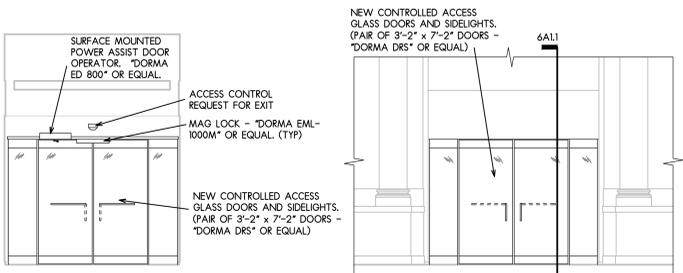


3 EAST ELEVATION
SCALE: 1/4" = 1'-0"

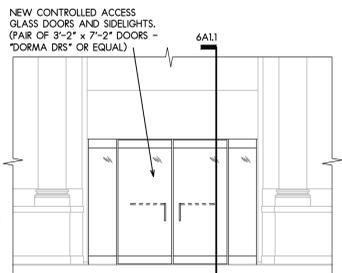


2 WEST ELEVATION
SCALE: 1/4" = 1'-0"

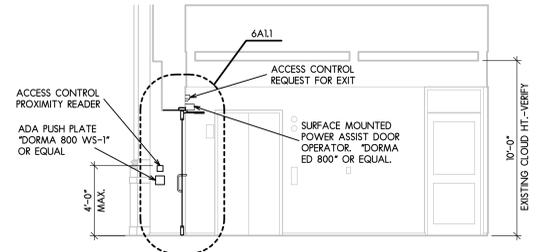


1 SOUTH ELEVATION
SCALE: 1/4" = 1'-0"

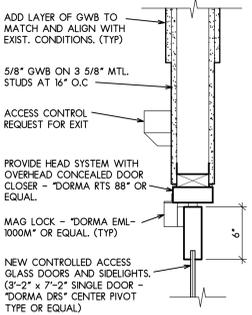


9 SECTION DETAIL
SCALE: 1 1/2" = 1'-0"

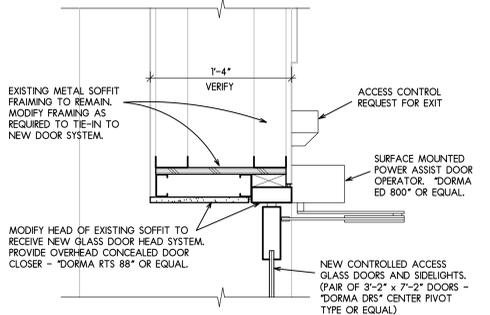


8 SECTION DETAIL
SCALE: 1 1/2" = 1'-0"

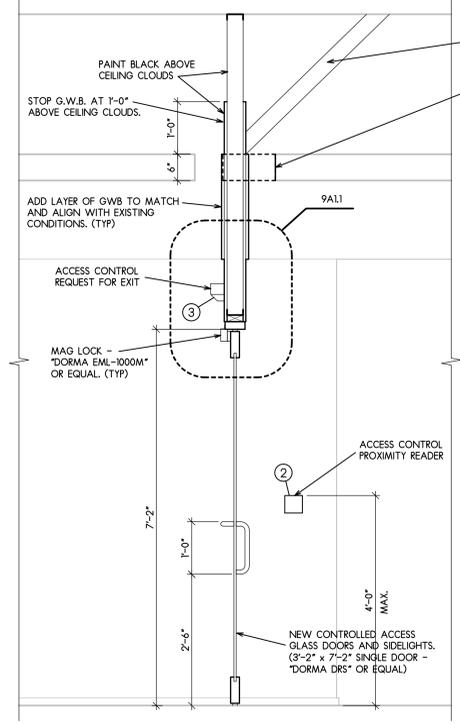

7 WALL SECTION
SCALE: 3/4" = 1'-0"

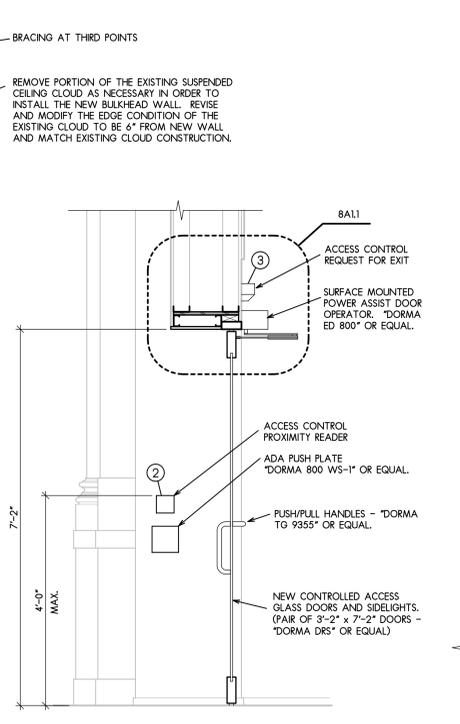

6 WALL SECTION
SCALE: 3/4" = 1'-0"

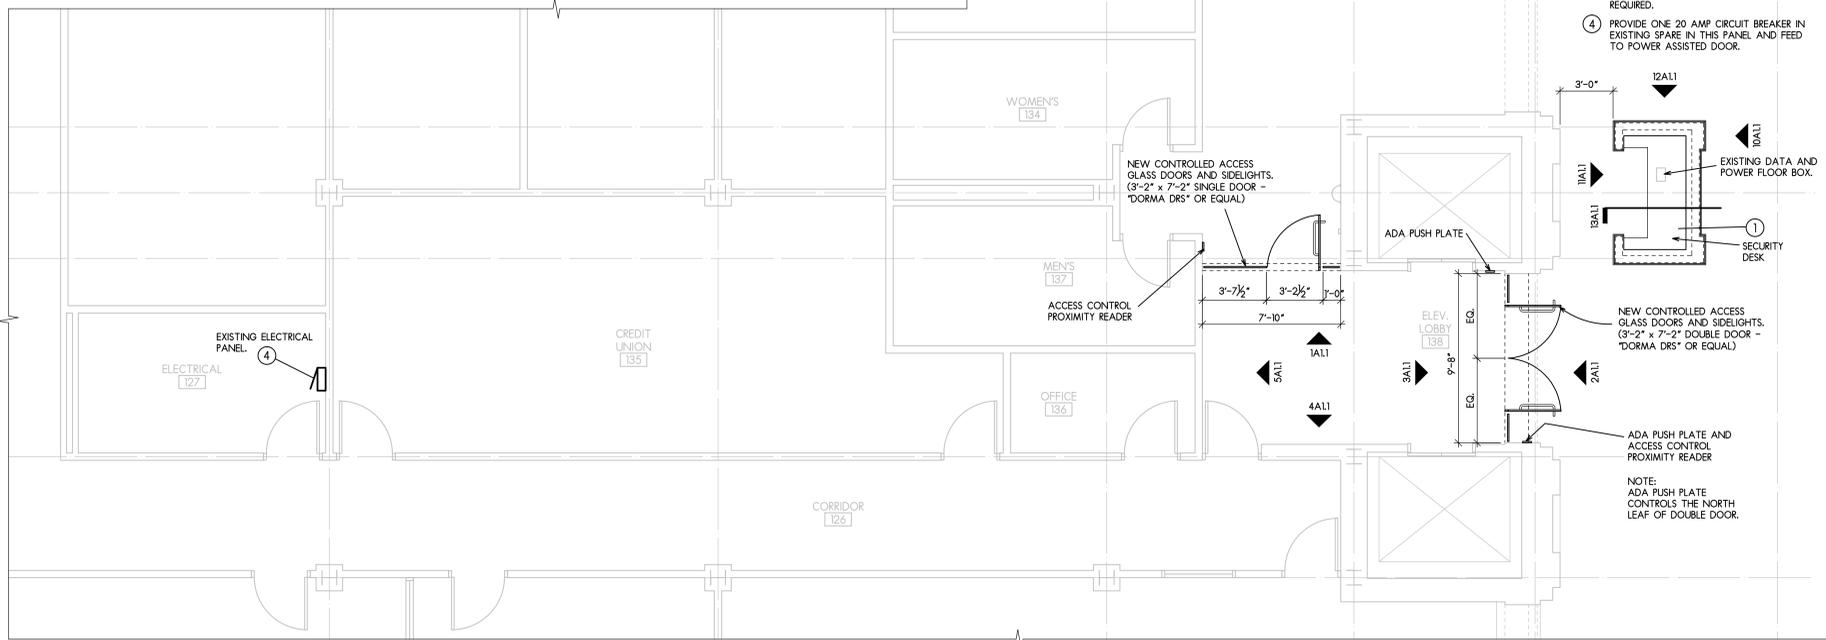

REFLECTED CEILING FIRST FLOOR PLAN
SCALE: 1/4" = 1'-0"

KEYED NOTES:

- 1 PROVIDE ONE BUTTON TO OPEN NORTH LEAF OF DOUBLE DOORS (ADA ACCESS). PROVIDE ONE "PANIC" BUTTON TO NOTIFY SECURITY VENDOR (PER-MAR).
- 2 PROVIDE PROXIMITY READER. TIE INTO EXISTING ACCESS CONTROL SYSTEM. FIELD VERIFY TYPE OF PROXIMITY READER TO MATCH EXISTING. FIELD VERIFY IF ADDITIONAL HEADEND EQUIPMENT NEEDED TO ACCOMMODATE ADDITIONAL PROXIMITY READERS. TIE INTO EXISTING FIRE ALARM SYSTEM TO DISENGAGE MAGNETIC LOCK ON ALARM.
- 3 PROVIDE MOTION SENSING REQUEST FOR EXIT. TIE INTO EXISTING ACCESS CONTROL SYSTEM. PROVIDE A DOOR CONTACT IF REQUIRED.
- 4 PROVIDE ONE 20 AMP CIRCUIT BREAKER IN EXISTING SPARE IN THE PANEL AND FEED TO POWER ASSISTED DOOR.

ARCHITECTURAL SYMBOLS :



FIRST FLOOR PLAN
SCALE: 1/4" = 1'-0"



ISSUED FOR:	DATE:
PROJECT NUMBER	23112
SHEET NUMBER	A1.1
DRAWN	APPROVED
DLS	GLT